

GAS MAIN EXTENSION NORTH PEMBROKE ROAD PEMBROKE, NEW HAMPSHIRE


PREPARED FOR: LIBERTY UTILITIES 15 BUTTRICK ROAD LONDONDERRY, NEW HAMPSHIRE 03053

PREPARED BY: KEACH-NORDSTROM ASSOCIATES, INC. 10 COMMERCE PARK NORTH, SUITE 3 BEDFORD, NEW HAMPSHIRE 03110 (603) 627-2881

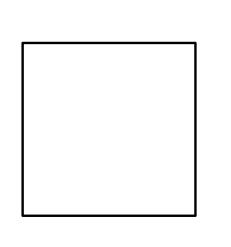

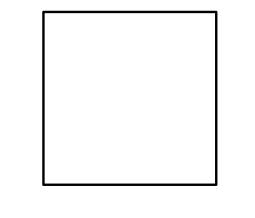




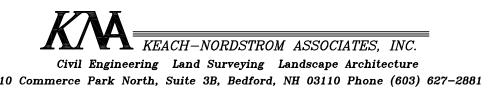


APRIL 2, 2019 LAST REVISED: JUNE 26, 2019 PROJECT NO. 18-0910-1

SHEET	TITLE


SHEET TITLE	SHEET No.
GAS MAIN EXTENSION OVERVIEW PLAN	1
GAS MAIN EXTENSION LAYOUT PLAN	2 - 4
GAS MAIN EXTENSION PROFILE PLAN	5
CONSTRUCTION DETAILS	6 - 7

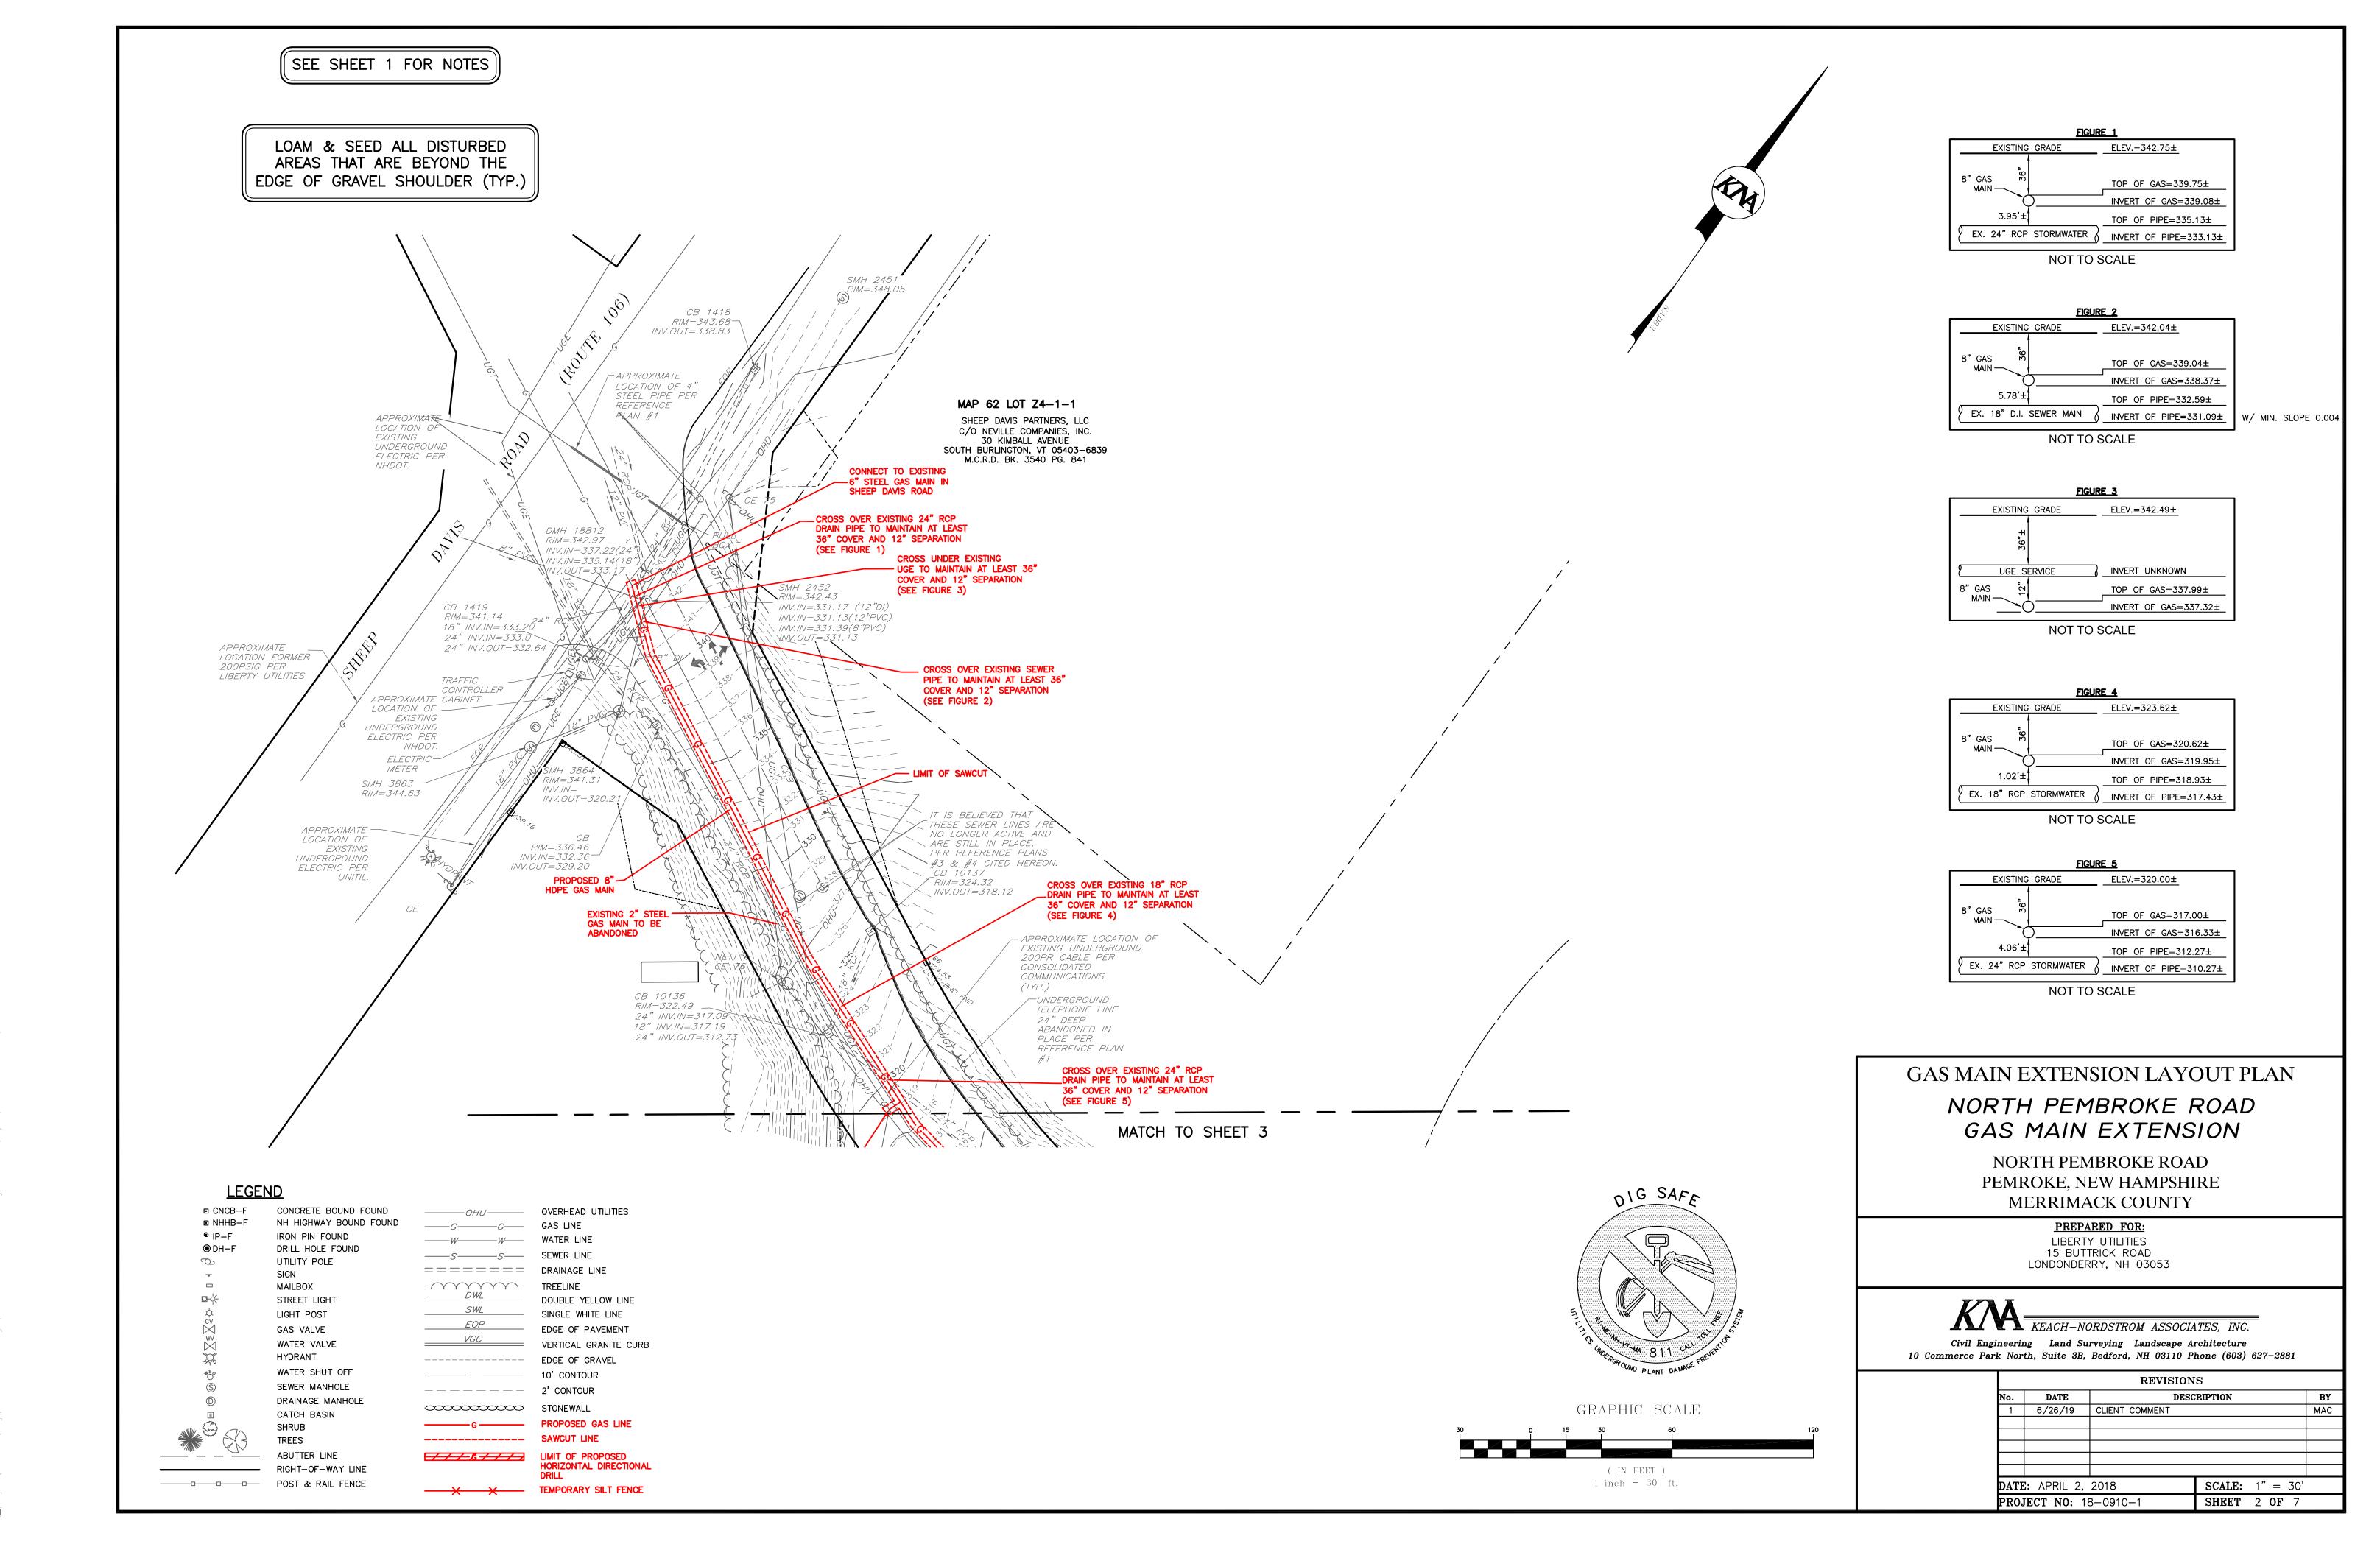


U:\ project\1809101\dwa\Production Drawings\1809101—GAS LINE PLAN.dwa. GAS MAIN. 6/26/2019-9:32:12 AM. mchamberlain

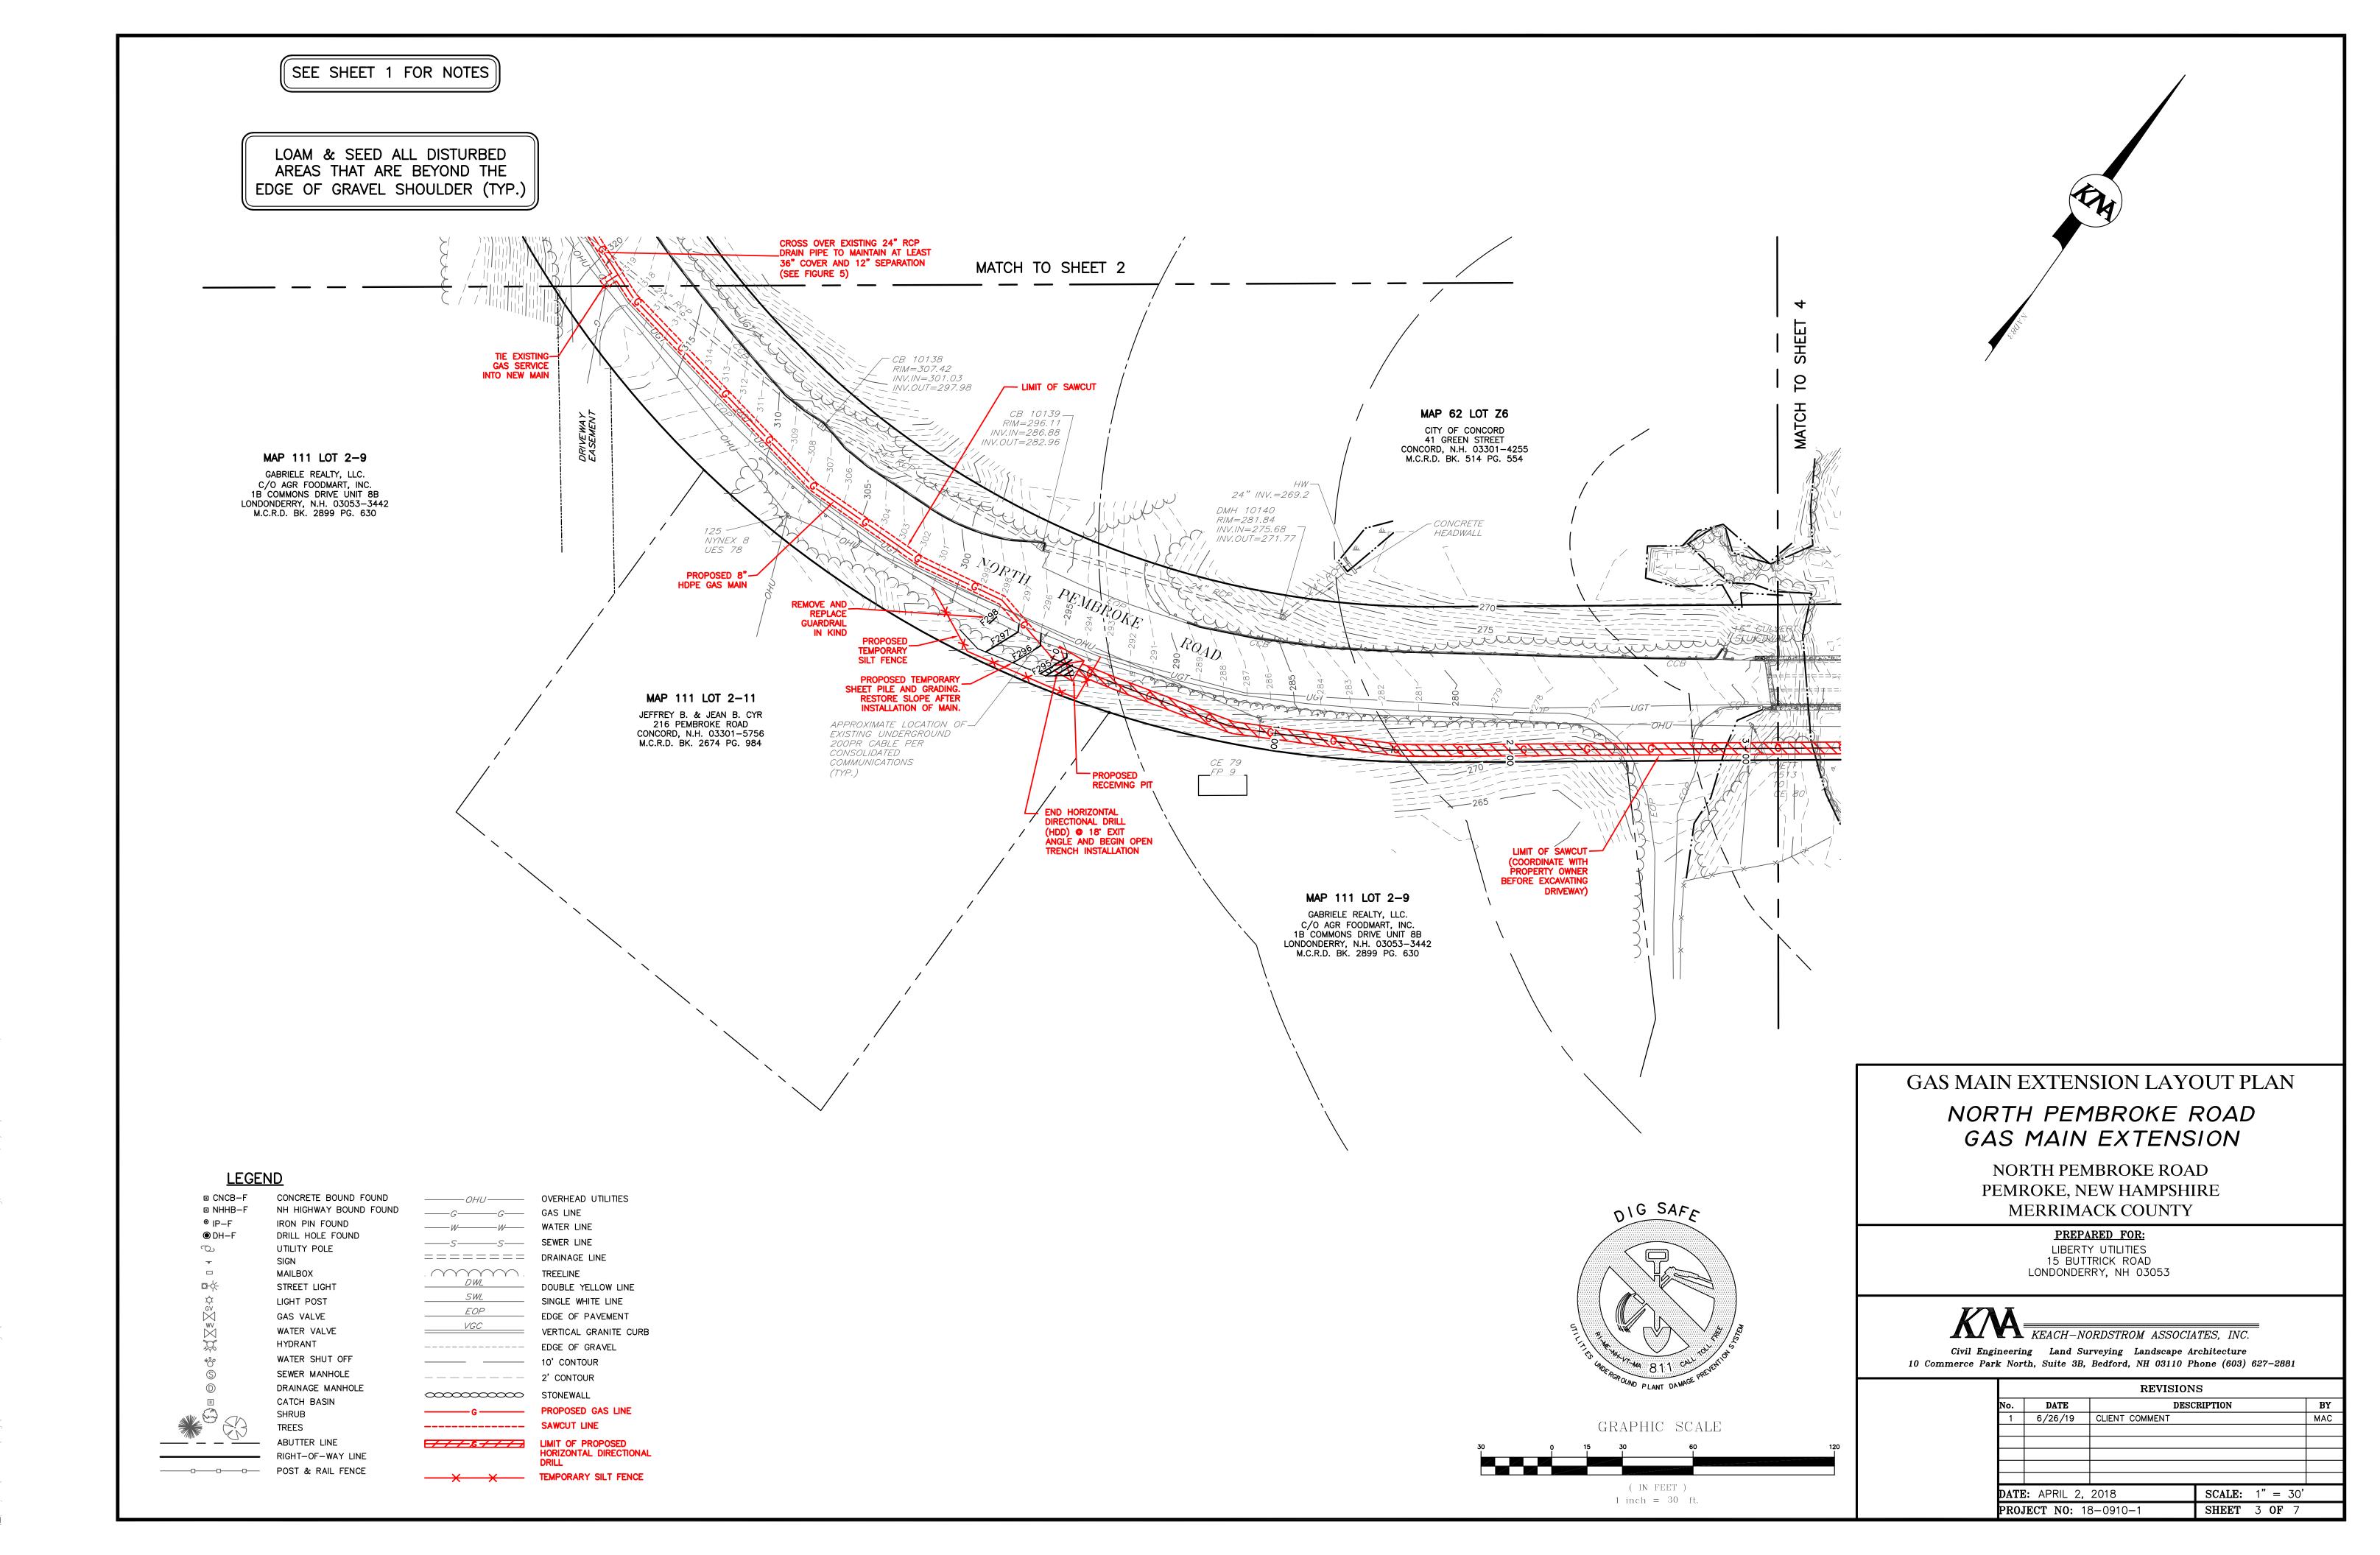

U:\ project\1809101\dwa\Production Drawings\1809101—GAS HNF PLAN.dwa. GAS MAIN. 6/26/2019 9:33:02 AM. mchamberlain

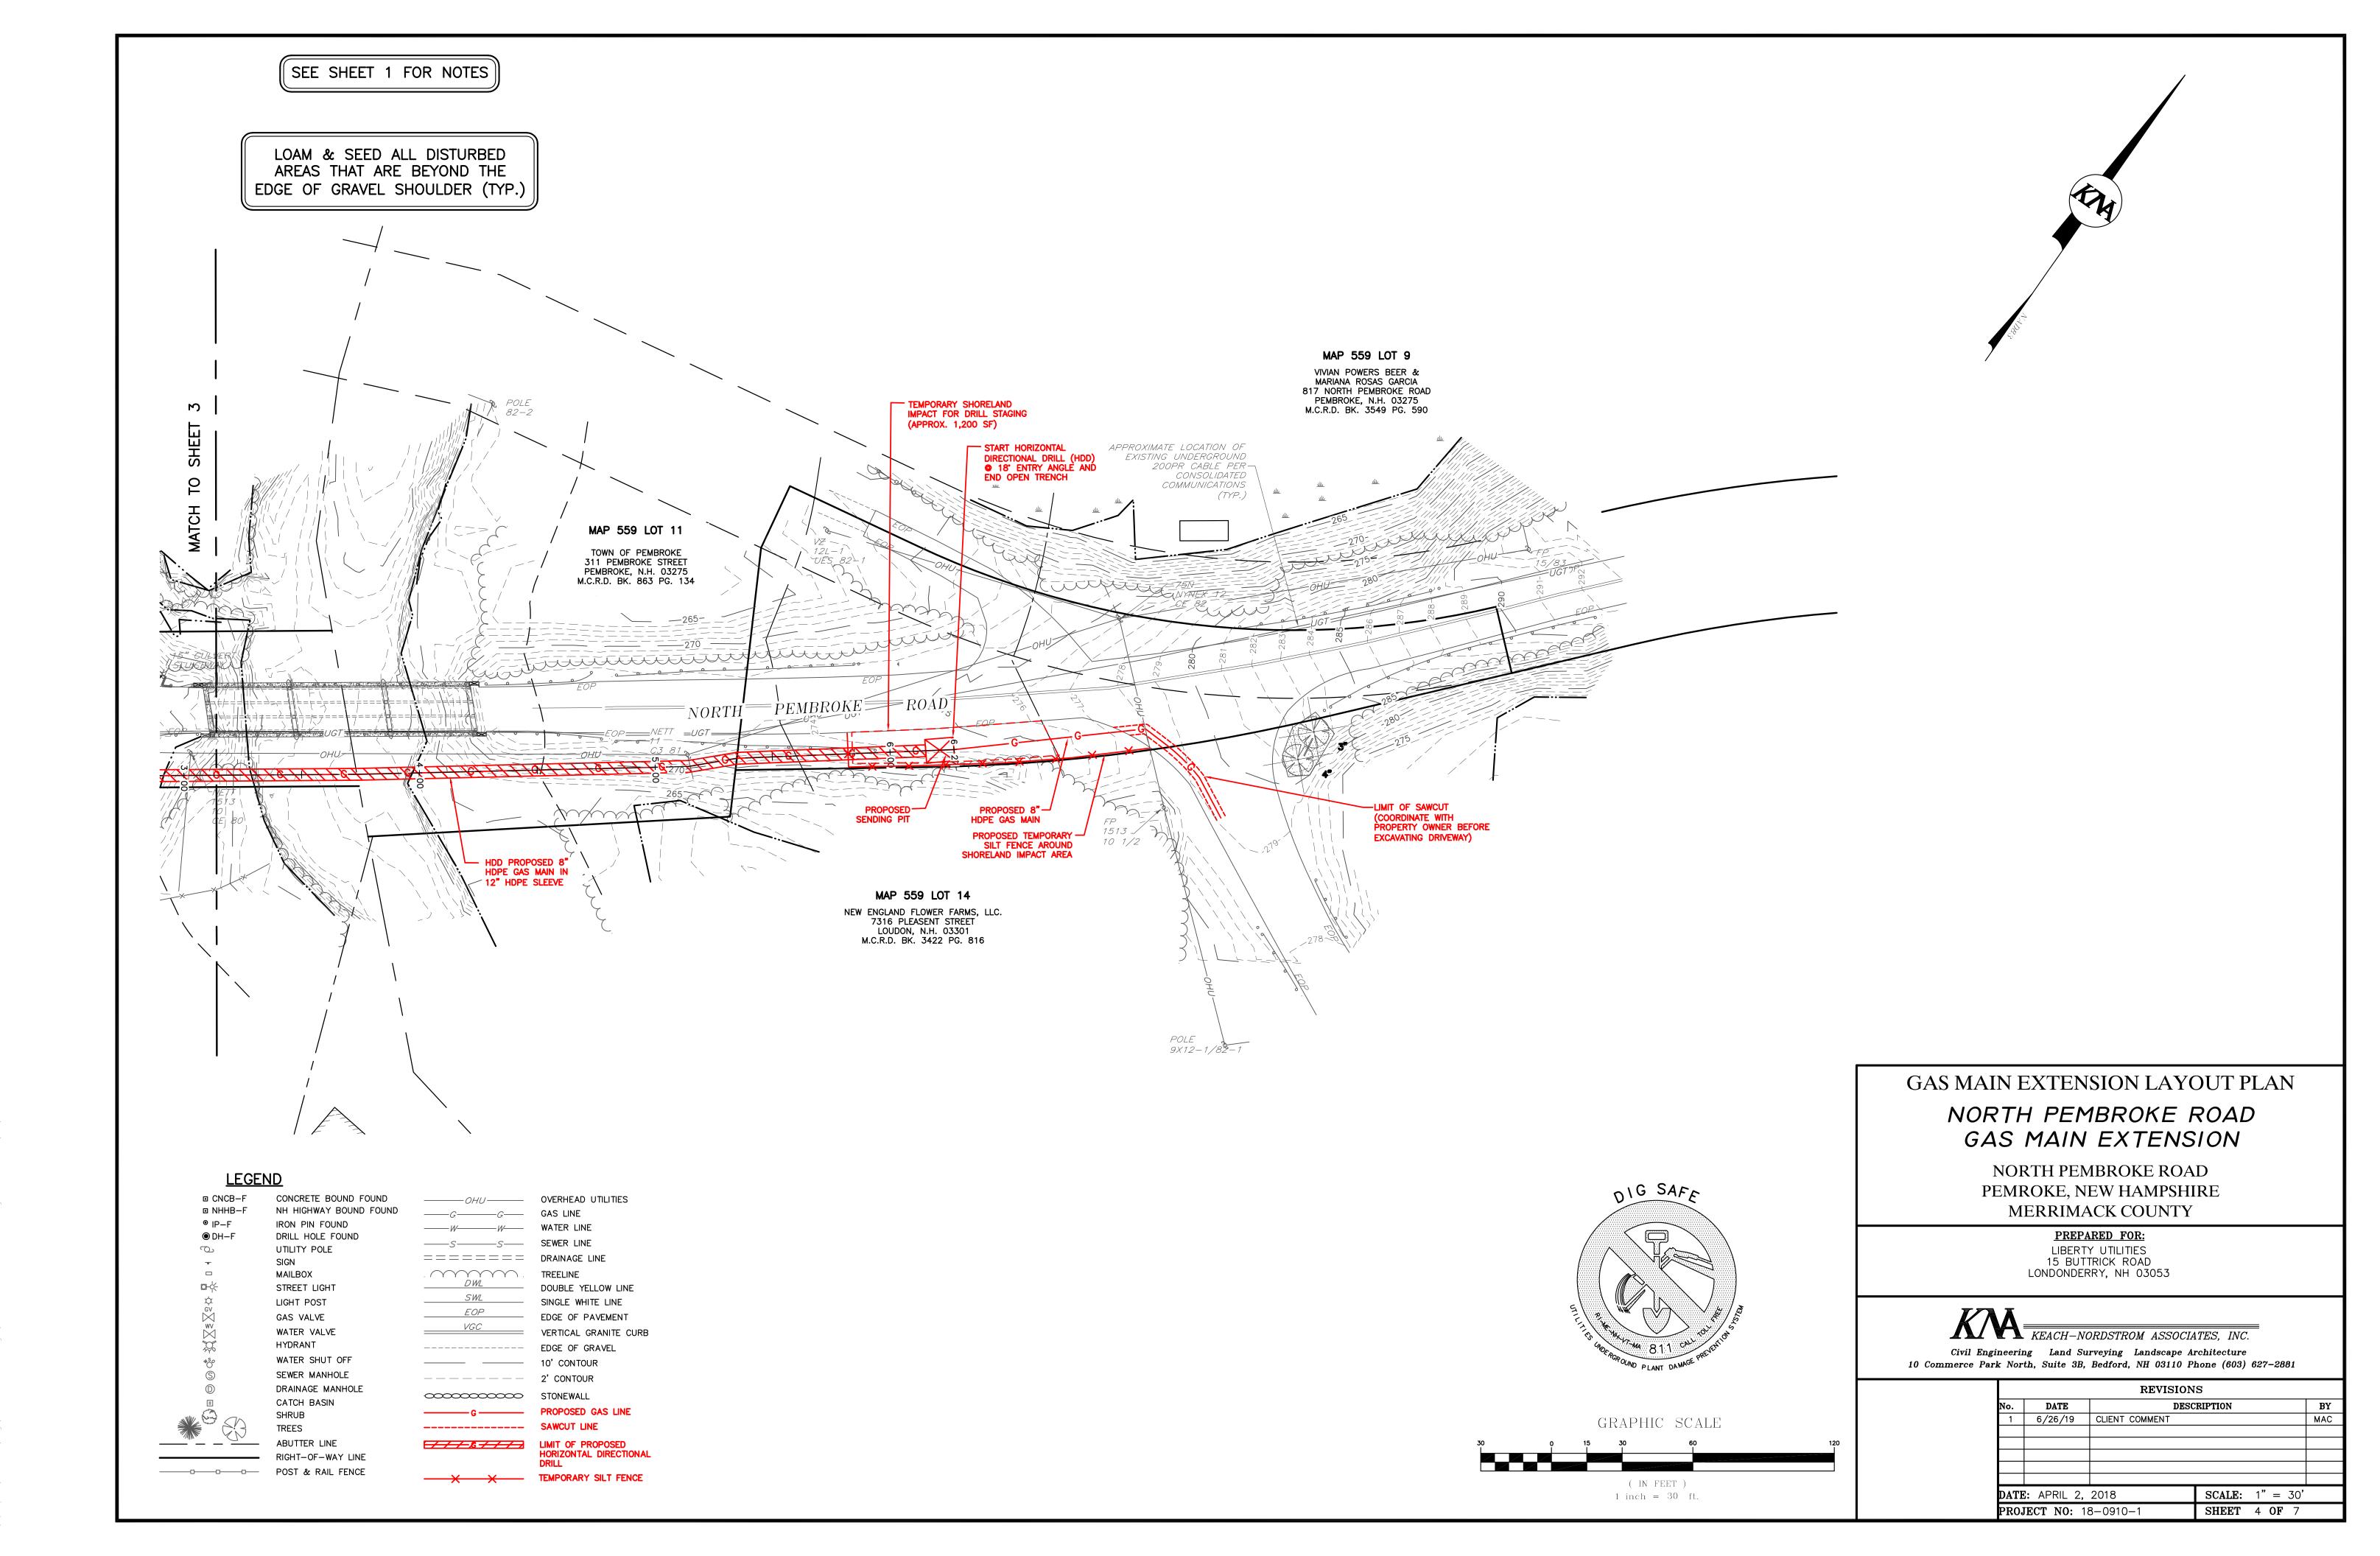

U:_project\1809101\dwq\Production Drawings\1809101—GAS LINE PLAN.dwg, GAS MAIN, 6/26/2019 9:36:50 AM, mchamberlain

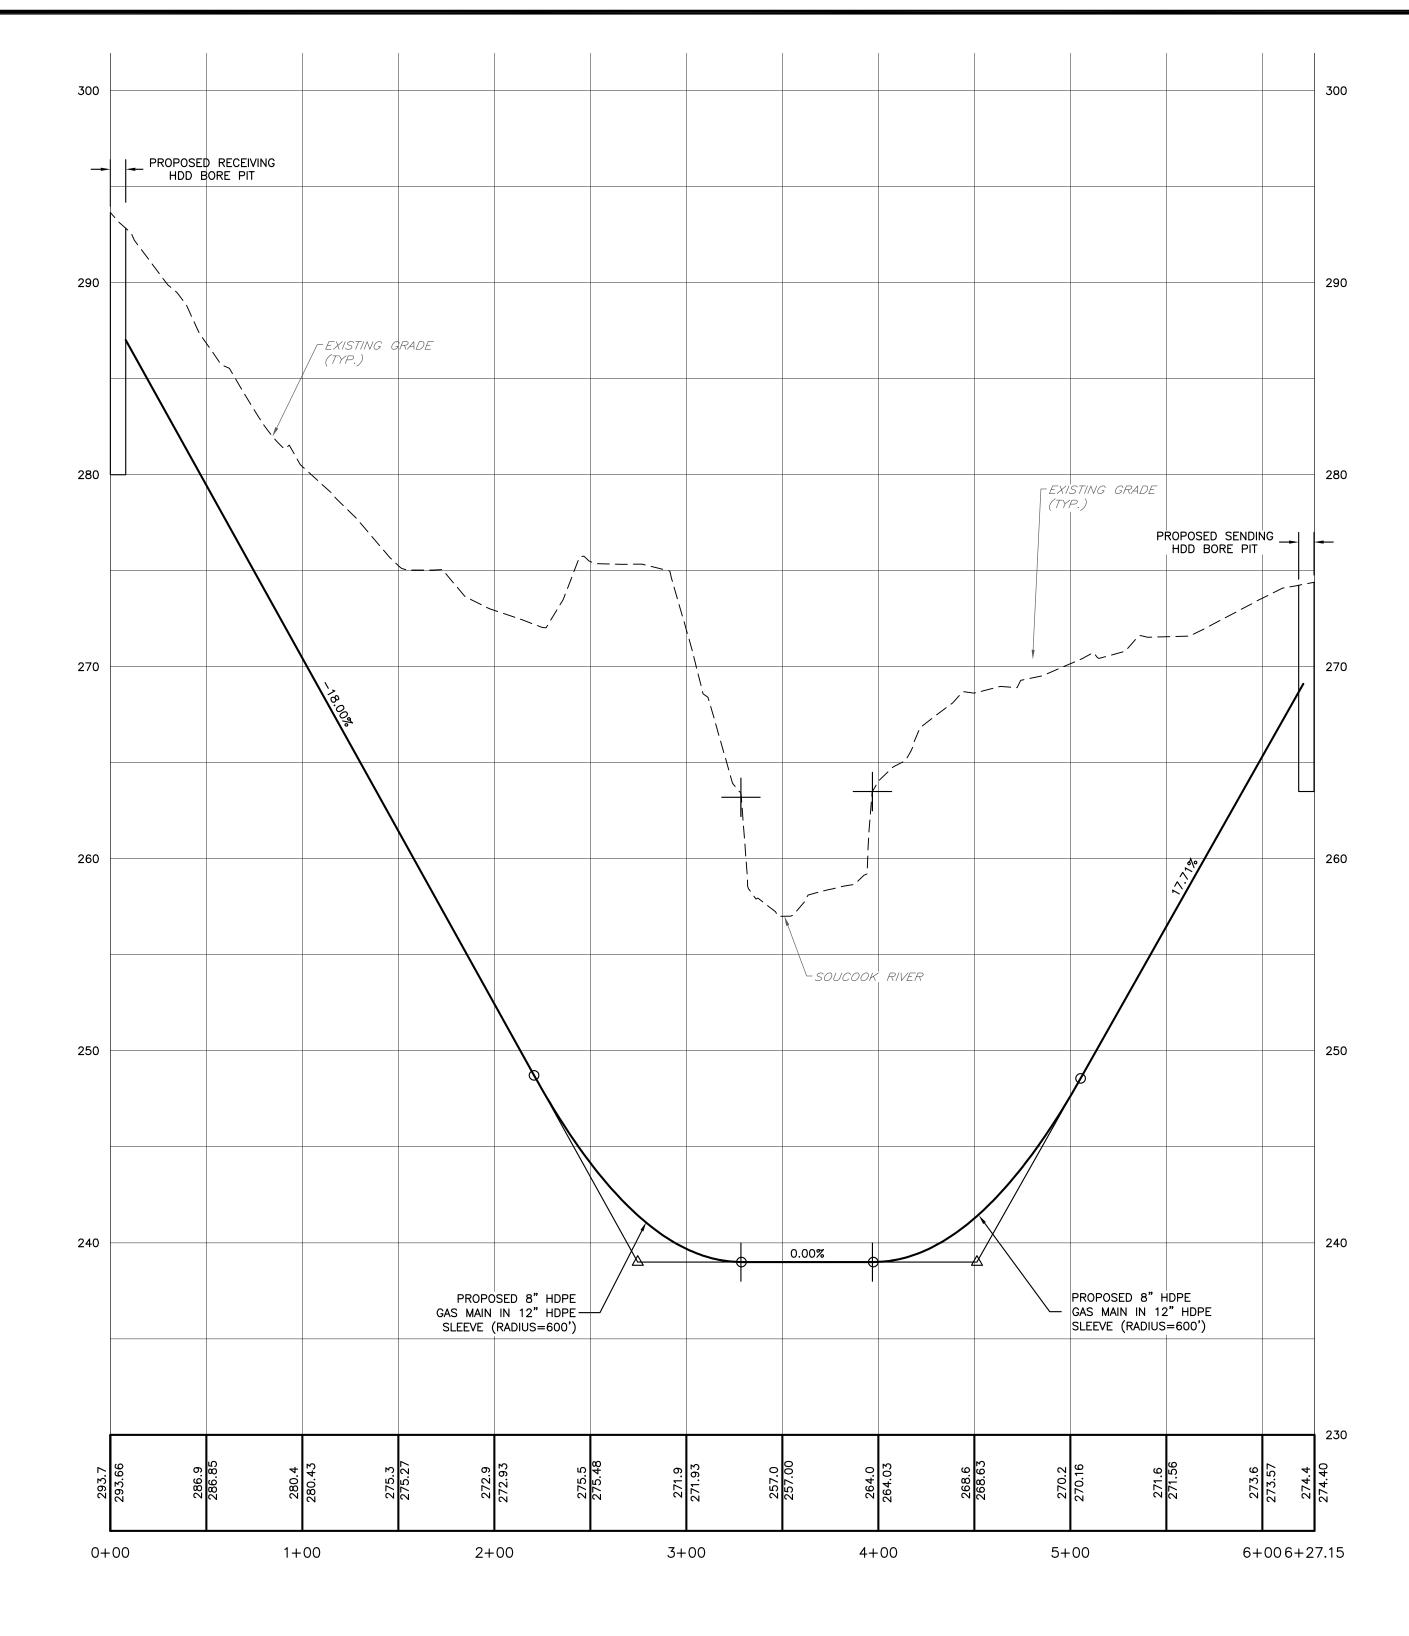

LEGEND

TREES

POST & RAIL FENCE

ABUTTER LINE RIGHT-OF-WAY LINE

<u>LEGEI</u>	<u> </u>		
CNCB-F NHHB-F IP-F DH-F CV WV WV SS	CONCRETE BOUND FOUND NH HIGHWAY BOUND FOUND IRON PIN FOUND DRILL HOLE FOUND UTILITY POLE SIGN MAILBOX STREET LIGHT LIGHT POST GAS VALVE WATER VALVE HYDRANT WATER SHUT OFF SEWER MANHOLE		OVERHEAD UTILITIES GAS LINE WATER LINE SEWER LINE DRAINAGE LINE TREELINE DOUBLE YELLOW LIN SINGLE WHITE LINE EDGE OF PAVEMENT VERTICAL GRANITE OF EDGE OF GRAVEL 10' CONTOUR 2' CONTOUR
(D)	DRAINAGE MANHOLE CATCH BASIN	G	PROPOSED GAS LINI

PROPOSED GAS MAIN HDD PROFILE

SCALE: 1" = 50'(HORIZ.)1" = 5'(VERT.) GAS MAIN EXTENSION PROFILE PLAN

NORTH PEMBROKE ROAD

GAS MAIN EXTENSION

NORTH PEMBROKE ROAD PEMROKE, NEW HAMPSHIRE MERRIMACK COUNTY

PREPARED FOR:
LIBERTY UTILITIES
15 BUTTRICK ROAD
LONDONDERRY, NH 03053

KEACH-NORDSTROM ASSOCIATES, INC.


Civil Engineering Land Surveying Landscape Architecture

10 Commerce Park North, Suite 3B, Bedford, NH 03110 Phone (603) 627-2881


REVISIONS						
DATE	DES	CRIPTION		BY		
6/26/19	CLIENT COMMENT			MAC		
TE: APRIL 2, 2018 SCALE: AS NOTED						
ECT NO: 18	3-0910-1	SHEET	5 OF 7			
	6/26/19 6: APRIL 2,	DATE DESC	DATE DESCRIPTION 6/26/19 CLIENT COMMENT E: APRIL 2, 2018 SCALE:	DATE DESCRIPTION 6/26/19 CLIENT COMMENT E: APRIL 2, 2018 SCALE: AS NOTED		


DIG SAFE


TYPICAL GAS MAIN OPEN EXCAVATION TRENCH NOT TO SCALE

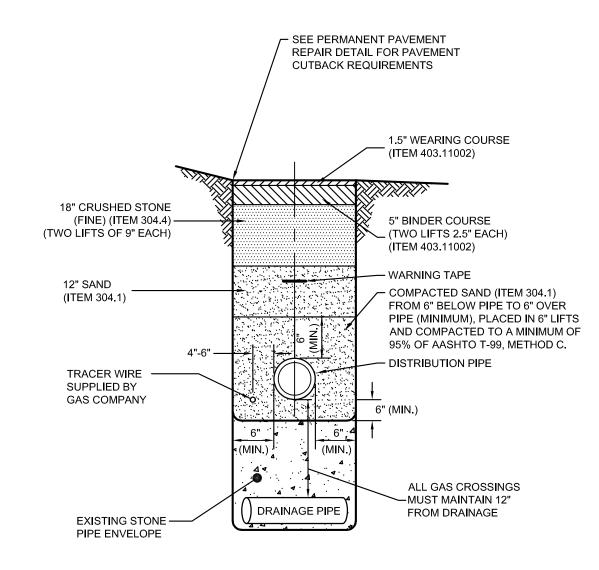

GAS MAIN OPEN EXCAVATION TRENCH IN ROADWAY NOT TO SCALE

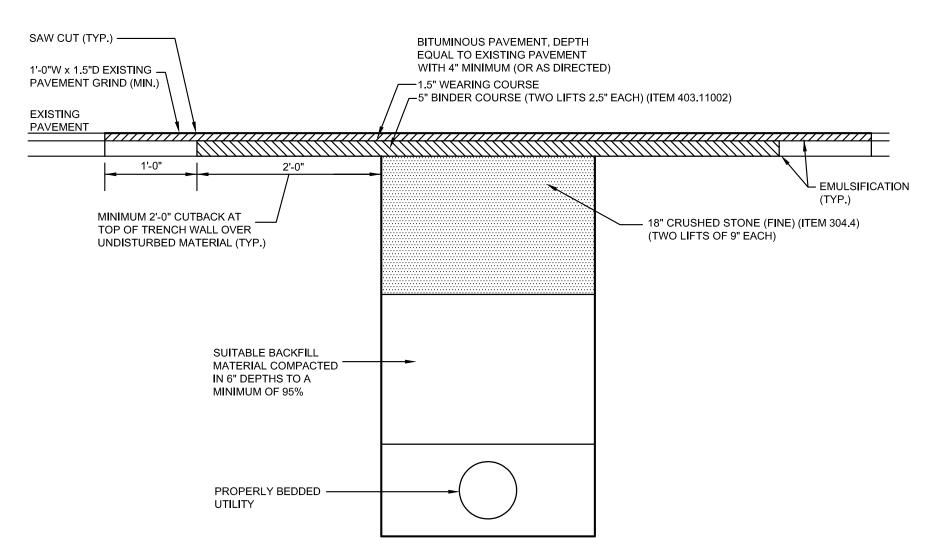

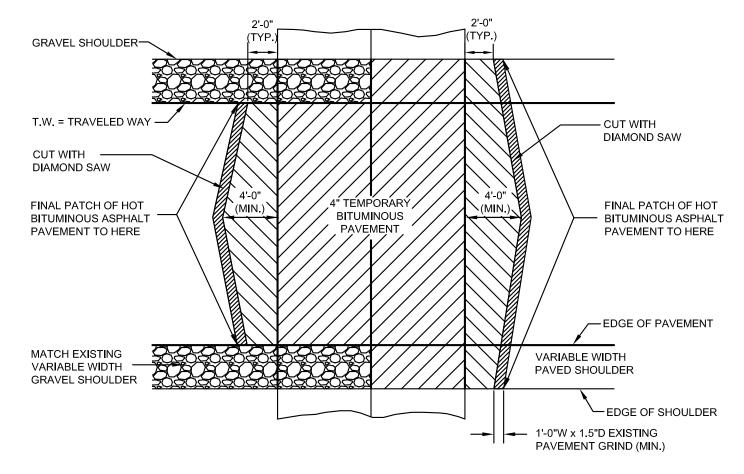

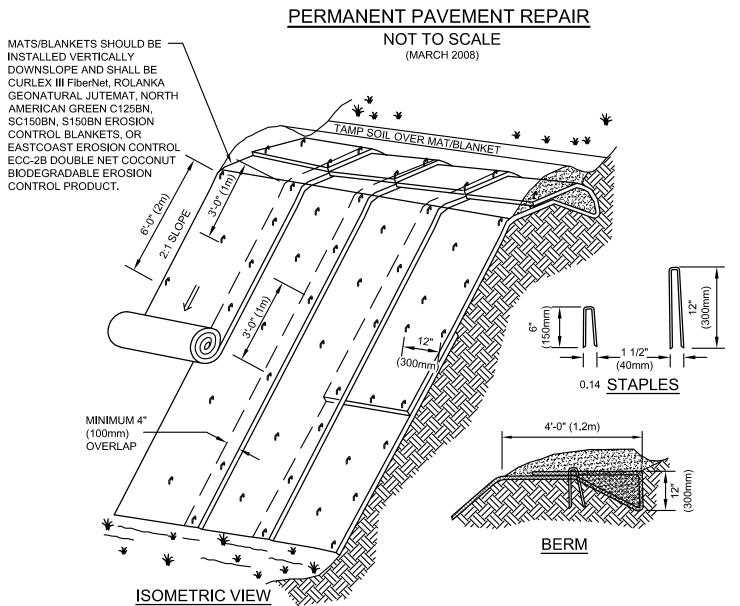


NOTES:

- 1. SLOPE SURFACE SHALL BE FREE OF ROCKS, CLODS, STICKS AND GRASS. MATS/ BLANKETS SHALL HAVE
- GOOD SOIL CONTACT.
 2. APPLY PERMANENT SEEDING BEFORE PLACING BLANKETS.
- 3. LAY BLANKETS LOOSELY AND STAKE OR STAPLE TO MAINTAIN DIRECT CONTACT WITH THE SOIL. DO NOT STRETCH.
- 4. EROSION CONTROL BLANKETS WITH WELDED PLASTIC OR BIODEGRADABLE PLASTIC NETTING OR THREAD SHALL NOT BE USED.
- 5. ACCEPTABLE EROSION CONTROL BLANKETS INCLUDE: CURLEX III FiberNet, ROLANKA GEONATURAL JUTEMAT, NORTH AMERICAN GREEN C125BN, SC150BN, S150BN EROSION CONTROL BLANKETS, OR EASTCOAST EROSION CONTROL ECC-2B DOUBLE NET COCONUT BIODEGRADABLE EROSION CONTROL PRODUCT.

EROSION CONTROL BLANKETS - SLOPE INSTALLATION NOT TO SCALE

(AUGUST 2011)

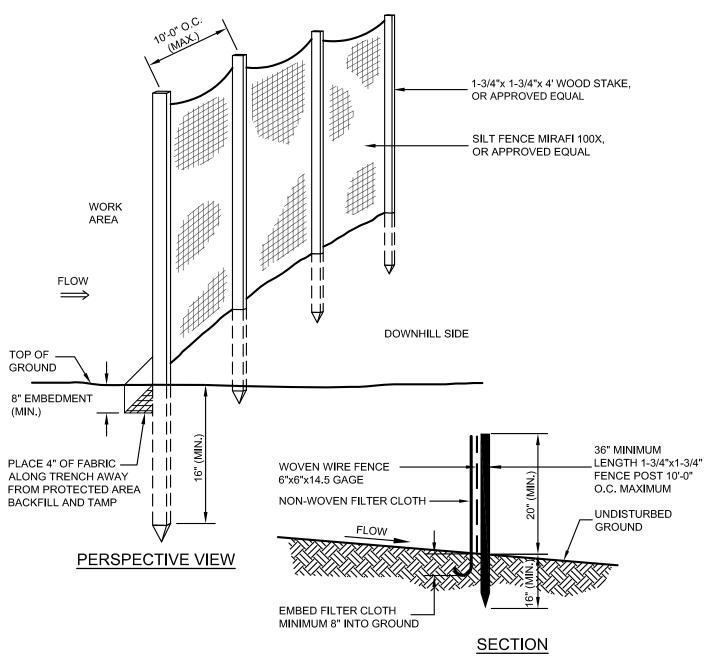

SILT FENCE DETAIL NOT TO SCALE


(MARCH 2008)


CONSTRUCTION SPECIFICATIONS:

- THE GEOTEXTILE FABRIC SHALL MEET THE DESIGN CRITERIA FOR SILT FENCES.
- THE FABRIC SHALL BE EMBEDDED A MINIMUM OF 8 INCHES INTO THE GROUND AND THE SOIL COMPACTED OVER THE EMBEDDED FABRIC.
- 3. WOVEN WIRE FENCE SHALL BE FASTENED SECURELY TO THE FENCE POSTS WITH WIRE TIE OR STAPLES WHERE NOTED OR AS DIRECTED BY DESIGN ENGINEER.
- 4. FILTER CLOTH SHALL BE FASTENED SECURELY TO THE WOVEN WIRE FENCE WITH TIES SPACED EVERY 24 INCHES AT THE TOP, MIDSECTION AND BOTTOM.
- 5. WHEN TWO SECTIONS OF FILTER CLOTH ADJOIN EACH OTHER, THEY SHALL BE OVERLAPPED BY 6 INCHES, FOLDED AND
- 6. FENCE POSTS SHALL BE A MINIMUM OF 36 INCHES LONG AND DRIVEN A MINIMUM OF 16 INCHES INTO THE GROUND. WOOD POSTS SHALL BE OF SOUND QUALITY HARDWOOD AND SHALL HAVE A MINIMUM CROSS SECTIONAL AREA OF 3.0 SQUARE INCHES.
- 7. MAINTENANCE SHALL BE PERFORMED AS NEEDED AND MATERIAL REMOVED WHEN "BULGES" DEVELOP IN THE SILT EENCE

MAINTENANCE

- 1. SILT FENCES SHALL BE INSPECTED IMMEDIATELY AFTER EACH RAINFALL AND AT LEAST DAILY DURING PROLONGED RAINFALL. ANY REPAIRS THAT ARE REQUIRED SHALL BE MADE IMMEDIATELY.
- 2. IF THE FABRIC ON A SILT FENCE SHOULD DECOMPOSE OR BECOME INEFFECTIVE DURING THE EXPECTED LIFE OF THE FENCE, THE FABRIC SHALL BE REPLACED PROMPTLY.
- 3. SEDIMENT DEPOSITS SHOULD BE INSPECTED AFTER EVERY STORM EVENT. THE DEPOSITS SHOULD BE REMOVED WHEN THEY REACH APPROXIMATELY ONE-HALF THE HEIGHT OF THE
- 4. SEDIMENT DEPOSITS THAT ARE REMOVED OR LEFT IN PLACE AFTER THE FABRIC HAS BEEN REMOVED SHALL BE GRADED TO CONFORM WITH THE EXISTING TOPOGRAPHY AND VEGETATED.

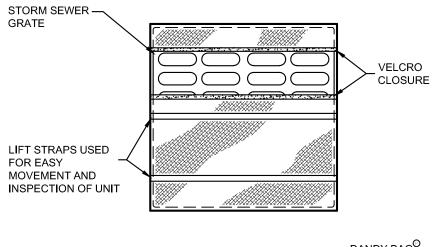

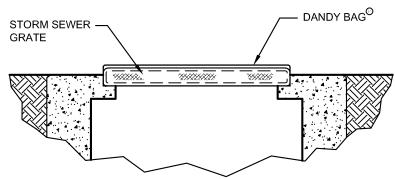

HI-FLOW DANDY BAG $^{\circ}$ (SAFETY ORANGE)

MECHANICAL PROPERTIES	TEST METHOD	UNITS	MARV
GRAB TENSILE STRENGTH	ASTM D 4632	kN (lbs)	1.62 (365) x 0.89 (200)
GRAB TENSILE ELONGATION	ASTM D 4632	%	24 x 10
PUNCTURE STRENGTH	ASTM D 4833	kN (lbs)	0.40 (90)
MULLEN BURST STRENGTH	ASTM D 3786	kPa (psi)	3097 (450)
TRAPEZOID TEAR STRENGTH	ASTM D 4533	kN (lbs)	0.51 (115) x 0.33 (75)
UV RESISTANCE	ASTM D 4355	%	90
APPARENT OPENING SIZE	ASTM D 4751	Mm (US Std Sieve)	0.425 (40)
FLOW RATE	ASTM D 4491	1/min/m ² (gal/min/ft ²)	5907 (145)
PERMITTIVITY	ASTM D 4491	Sec-1	2.1

DANDY BAG^O NOT TO SCALE (APRIL 2010)

CONSTRUCTION DETAILS NORTH PEMBROKE ROAD GAS MAIN EXTENSION

NORTH PEMBROKE ROAD PEMROKE, NEW HAMPSHIRE MERRIMACK COUNTY

PREPARED FOR:
LIBERTY UTILITIES
15 BUTTRICK ROAD
LONDONDERRY, NH 03053


KEACH-NORDSTROM ASSOCIATES, INC.

Civil Engineering Land Surveying Landscape Architecture

10 Commerce Park North, Suite 3B, Bedford, NH 03110 Phone (603) 627-2881


			REVISIO	NS				
No.	DATE		DE	SCRIPTION	1			BY
1	6/26/19	CLIENT	COMMENT					MAC
DATE: APRIL 2, 2018		SCA	LE:	AS	SHOW	/N		
PROJ	ECT NO: 18	3-0910)—1	SHE	ET	6 0	F 7	

U:_project\1809101\dwg\Production Drawings\1809101-DETAILS.dwg, Layout1, 6/26/2019 9:27:47 AM, mchamberlain

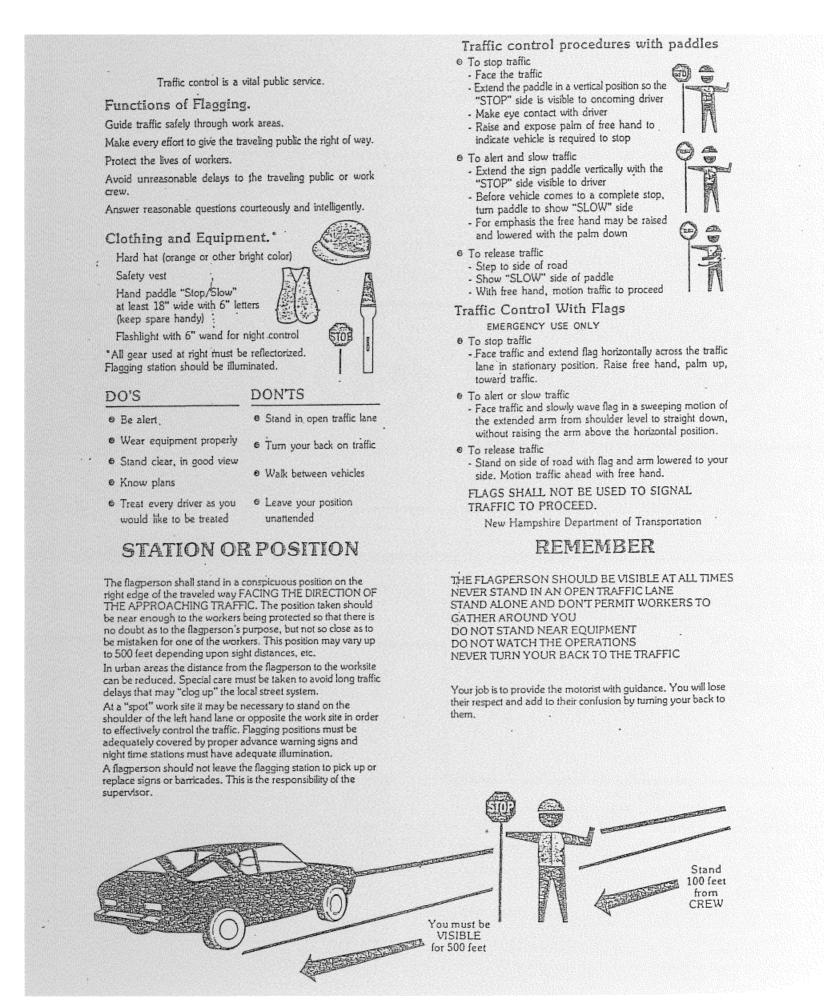

NHDOT DAYTIME TRAFFIC CONTROL PROCEDURE

NOT TO SCALE

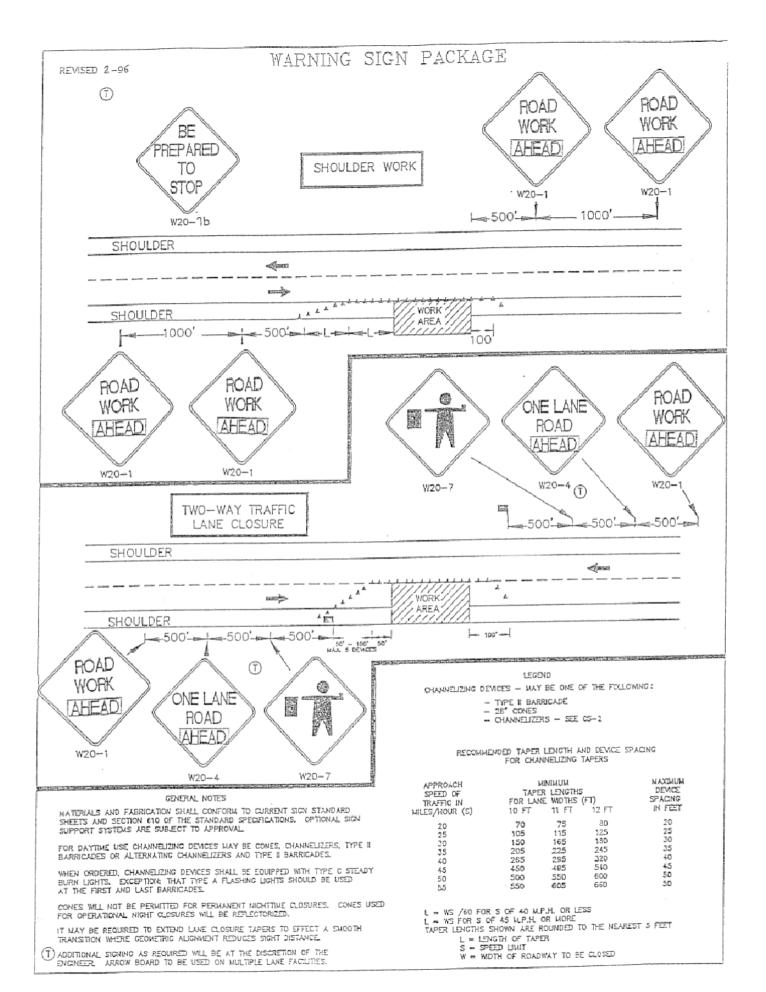

NHDOT WARNING SIGN PACKAGE DETAIL

NOT TO SCALE

CONSTRUCTION DETAILS NORTH PEMBROKE ROAD GAS MAIN EXTENSION

NORTH PEMBROKE ROAD PEMROKE, NEW HAMPSHIRE MERRIMACK COUNTY

PREPARED FOR:
LIBERTY UTILITIES
15 BUTTRICK ROAD
LONDONDERRY, NH 03053

KEACH-NORDSTROM ASSOCIATES, INC.

Civil Engineering Land Surveying Landscape Architecture

10 Commerce Park North, Suite 3B, Bedford, NH 03110 Phone (603) 627-2881

	REVISIONS						
	DATE	DESC	DESCRIPTION				
	6/26/19	CLIENT COMMENT			MAC		
			·				
E: APRIL 2, 2018 SCALE: AS SHOW				N			
JECT NO: 18-0910-1 SHEET 7 OF 7							
•							